

SUNBJECT TO CHOSEN MANUFACTURER
 WINDOWS SIZES MAY VARY FROM PLAN
 REFER TO MFG. FOR RSO SIZES

DIMENSIONS ON THIS PLAN GOVERN OVER ALL DRAWINGS
 REPORT ANY DISCREPENCIES TO View -it Design

I review and take responsibility for the design work on behalf Of a firm registered under subsection 2.17.4. of the O.B.C. I am qualified, and the firm is registered, in the appropriate classes/categories

1227 SQ. FT. N/A 1227 SQ. FT. 874 SQ. FT. 2101 SQ. FT.

DESCRIPTION 05/28/19 1. PERMIT READY DRAWINGS



PROPERTY OF WALL TO WALL


WALL TO WALL CONSTRUCTION 6716 SAWMILL RD. AYLMER ON

CELL: 519 -639-2933

RICKETTS 49324 DEXTER LINE MALAHIDE TWP.

FOUNDATION/SECTION

SCALE: As indicated REVIEWED BY: M.W. B.C.I.N. 110469 **A**0

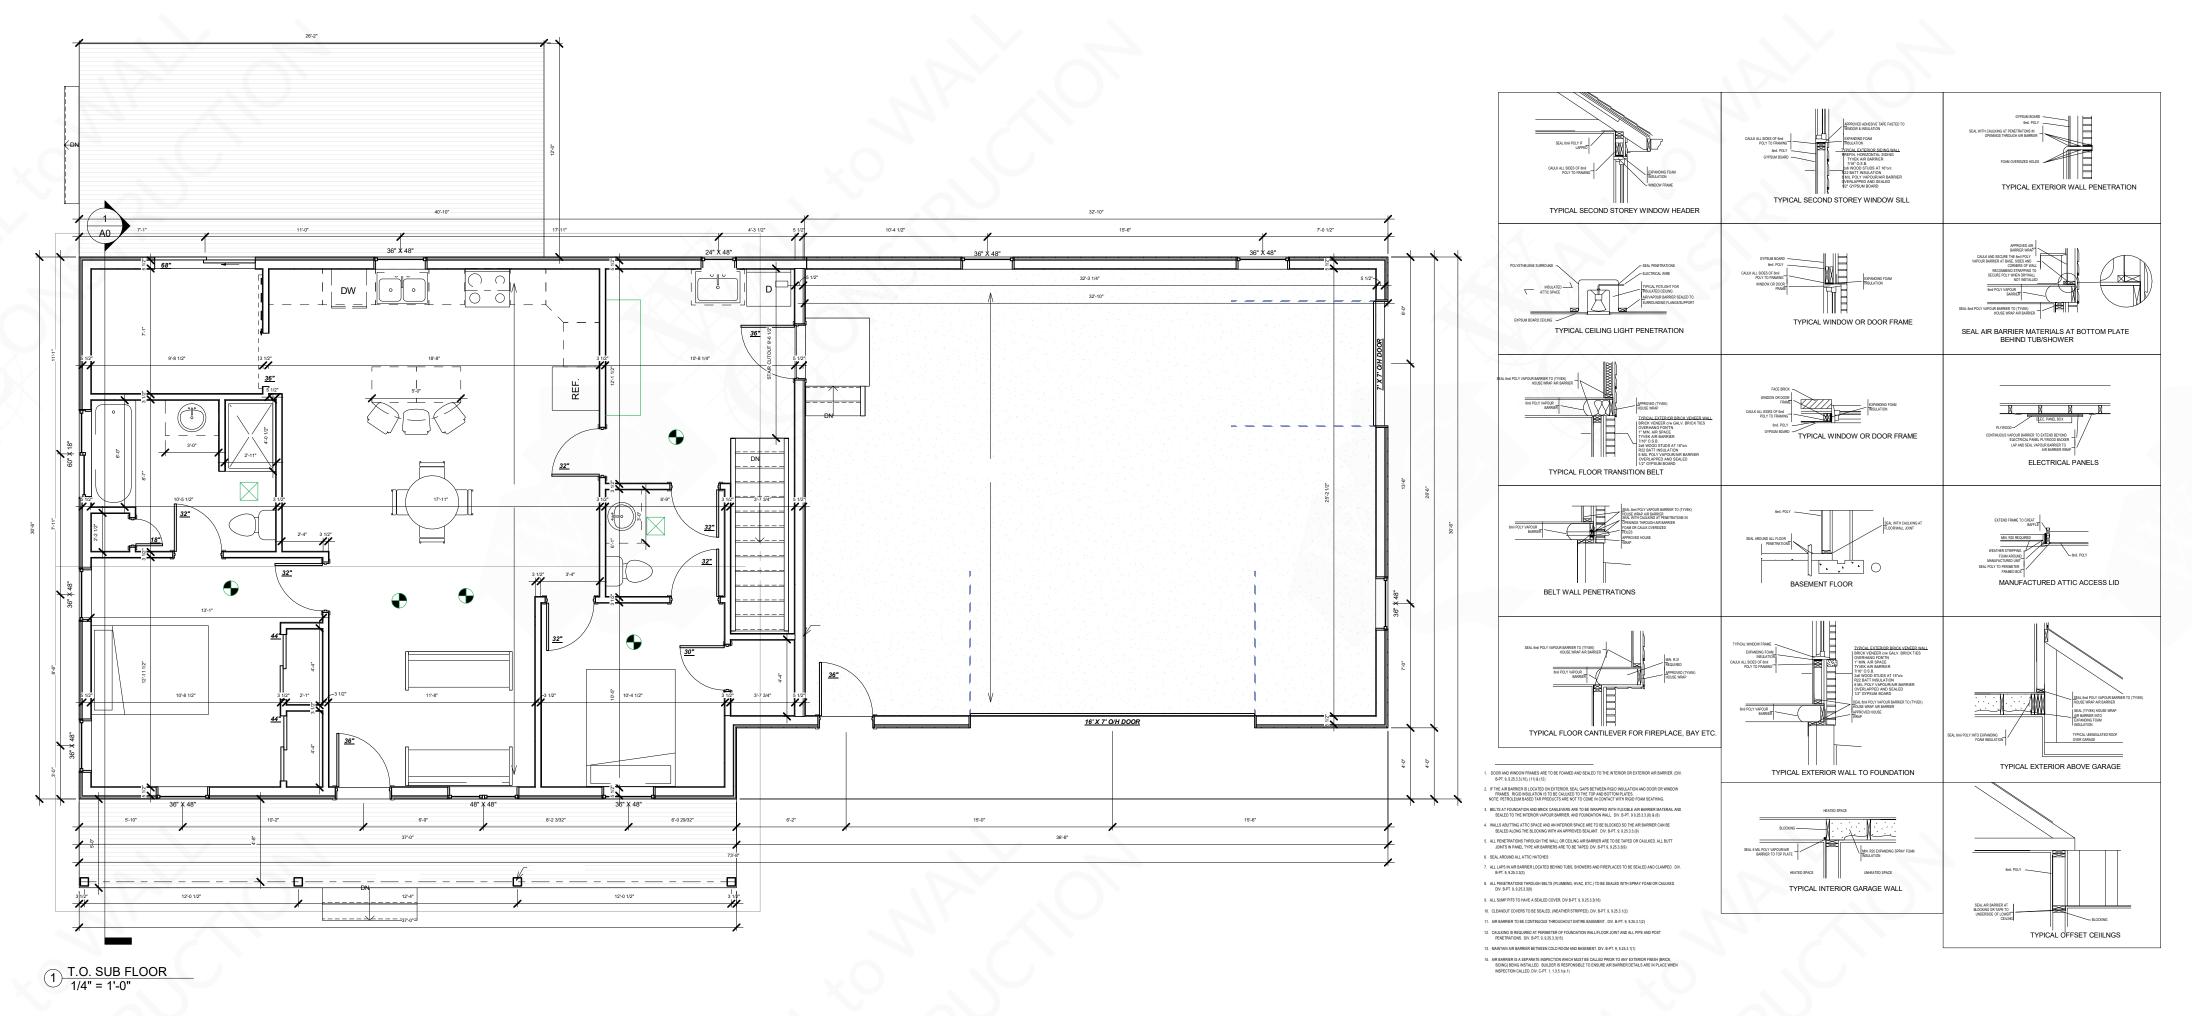

GENERAL NOTES:

CONTRACTOR SHALL REVIEW THE DESIGN DRAWINGS AND REPORT ANY ERRORS OR OMISSIONS TO THE DESIGNER PRIOR TO PROCEEDING WITH THE WORK OF THE CONTRACT. PROCEEDING WITHOUT NOTIFICATION, OR IF CHANGES ARE MADE WITHOUT THE CONTRACT. PROCEEDING WITHOUT NOTIFICATION, OR IF CHANGES ARE MADE WITHOUT THE APPROVAL OF THE DESIGNER, WILL VOID ALL RESPONSIBILITY AND LIABILITY OF THE DESIGNER

THE GENERAL CONTRACTOR SHALL PROVIDE MECHANICAL DRAWINGS FOR HEATING & AIR CONDITIONING SYSTEM AND HEAT LOSS & GAIN CALCULATIONS AND BALANCING REPORTS AS MAY BE REQUIRED BY AUTHORITIES HAVING

ALL CONSTRUCTION SHALL CONFORM TO THE REQUIREMENTS OF THE ONTARIO BUILDING CODE, ONTARIO REG. 403/97 AND ALL OTHER APPLICABLE CODES AND REQUIREMENTS OF THE MUNICIPALITY HAVING JURISDICTION.
IT SHALL BE THE RESPONSIBILITY OF THE CONTRACTOR TO CONFORM WITH THESE SECTIONS OF THE CODE WHERE APPLICABLE AND BE FAMILIAR WITH PART 9 OF THE CODE.

STAIR DIMENSIONS (UNLESS OTHERWISE SHOWN ON DRAWINGS)

EXTERIOR MAX RISE 200mm (7 7/8") MIN. RUN 210mm (8 1/4") MIN. TREAD 235mm (9 1/4") NOSING 25mm (1")

MAX RISE 200mm (7 7/8") MIN. RUN 210mm (8 1/4") MIN. TREAD 235mm (9 1/4") NOSING 25mm (1")

GUARD HEIGHT - 2' 0" ABOVE GRADE = 900mm (35") ONITIONIN RISE A KINN ON ANY FLIGHT OF STAIRS
MINIMUM HEADROOM 1950mm (65")
GUARD HEIGHT AT LANDING 900mm (35")
AT STAIRS BETWEEN 800mm (31") & 900mm (35")
GUARD SPACING 100mm (4") NON CLIMBABLE
HANDRAILS INSTALLED BETWEEN 800mm (31") & 920mm (36") CONCRETE STAIRS OVER 2 RISERS ARE REQUIRED TO BE SUPPORTED ON FOUNDATION HANDRAIL REQ'D ON STAIRS OVER 3 RISERS INSTALLED BETWEEN 800mm (31") & 920mm (36")

CONCRETE

AS PER OBC SECTION 9.15 & 9.16

ALL CONCRETE FOOTINGS SHALL BEAR ON UNDISTURBED SOIL WITH A MIN SOIL BEARING PRESSURE OF 2000 PSF CONCRETE FOR FOOTINGS & FOUNDATIONS TO HAVE MIN. COMPRESSIVE STRENGTH OF 20 MPa (2900 PSI) AT 28 DAYS

MAX RISE 600mm (24") FOR FIRM SOIL MAX RISE 400mm (16" FOR SAND OR GRAVEL MIN RUN BETWEEN RISERS 600mm (24") ANGLE OF REPOSE IS 45°

CONCRETE FOUNDATION WALLS SHALL EXTEND TO 6" MIN. ABOVE FINISHED GRADE FOOTING DESIGN MIN. 6" DEEP X 4" MIN. PROJECTION BEYOND FOUNDATION WALL AND MIN. OF 16' WIDE CONCRETE FOUNDATIONS SHALL BE CONSTRUCTED TO SUFFICIENT DEPTH TO PROVIDE ADEQUATE FROST PROTECTION

WOOD FRAME CONSTRUCTION

ALL STRUCTURAL LUMBER TO BE SPF#2 CONSTRUCTION OR BETTER UNLESS NOTED OTHERWISE, LUMBER SIZES TO BE AS DETERMINED FROM SPAN TABLES OF THE BUILDING CODE.
SILL PLATES SHALL BE ANCHORED TO THE FOUNDATION WITH 1/2" ANCHOR BOLTS 7"-10" MAX ON SPACING WITH 4" MIN.

HEAT TRANSFER, AIR LEAKAGE & CONDENSATION CONTROL

AS PER OBC SECTION 9.25

PROVIDE AN AIR BARRIER IN STRICT ACCORDANCE WITH OBC SECTION 9.23.3 INSULATION REQUIREMENTS: MIN. R19 + R5ci IN ALL EXTERIOR WALLS

MIN. R12 + R5ci IN FOUNDATION WALLS ENCLOSING HEATED SPACE

VAPOUR BARRIERS SHALL BE INSTALLED TO PROTECT THE ENTIRE SURFACE OF ANY THERMALLY INSULATED WALL,CEILING & FLOOR ASSEMBLIES AND TO BE INSTALLED ON THE WARM SIDE OF THE INSULATION. ALL PENETRATION OF THE VAPOUR BARRIER TO BE SEALED TO MAINTAIN THE INTEGRITY OF THE BARRIER SYSTEM..

EXTERIOR DOORS & WINDOWS

DOORS TO DWELLING SHALL BE OPERABLE FROM THE INSIDE WITHOUT THE USE OF KEYS
ALL EXTERIOR DOORS IF WOOD SHALL CONFORM TO CAN/CSA-O132.2-M, STEEL INSULATED CONFORM TO CAN/CGSB-82.5M
WINDOW GLASS SIZE TO COMPLY WITH CURRENT OBC REQUIREMENTS
ALL DOORS & WINDOWS SHALL COMPLY WITH OBC SECTION 9.7.6- RESISTANCE TO FORCED ENTRY
EVERY FLOOR LEVEL CONTAINING A BEDROOM SHALL HAVE AT LEAST 1 OUTSIDE WINDOW THAT CAN BE OPENED FROM THE INSIDE
WITHOUT THE USE OF TOOLS. THESE WINDOWS MUST HAVE AN UNOBSTRUCTED OPEN AREA OF 3.8 SQ.FT. WITH NO DIMENSION LESS THAN 15"


VENTILATION

AS PER OBC SECTION 9.32.3.4

PROVIDE VENTILATION FOR ROOF SPACES AT A RATIO OF 1 SQ.FT. MIN OF UNOBSTRUCTED VENTILATION FOR EACH 300 SQ.FT. OF INSULATED CEILING AREA WITH NOT MORE THAN HALF THE REQUIRED VENTILATION LOCATED AT THE EAVES.
PROVIDE BAFFLES AT THE AZVES TO PERMIT FREE UNOSSTRUCTED AN FLOW
PROVIDE MECHANICAL VENTILATION SYSTEM TO THE REQUIREMENTS OF OBC 9.32.2 WITH CLEARLY LABELED PRINCIPAL EXHAUST FAN
MANILAL SUMMENT.

ELECTRICAL

ALL LIGHTING AND ELECTRICAL TO COMPLY WITH OBC 9.34
ALL FLOOR LEVELS SHALL BE EQUIPPED WITH INTERCONNECTED SMOKE DETECTORS (TYPICAL ALL UNITS)

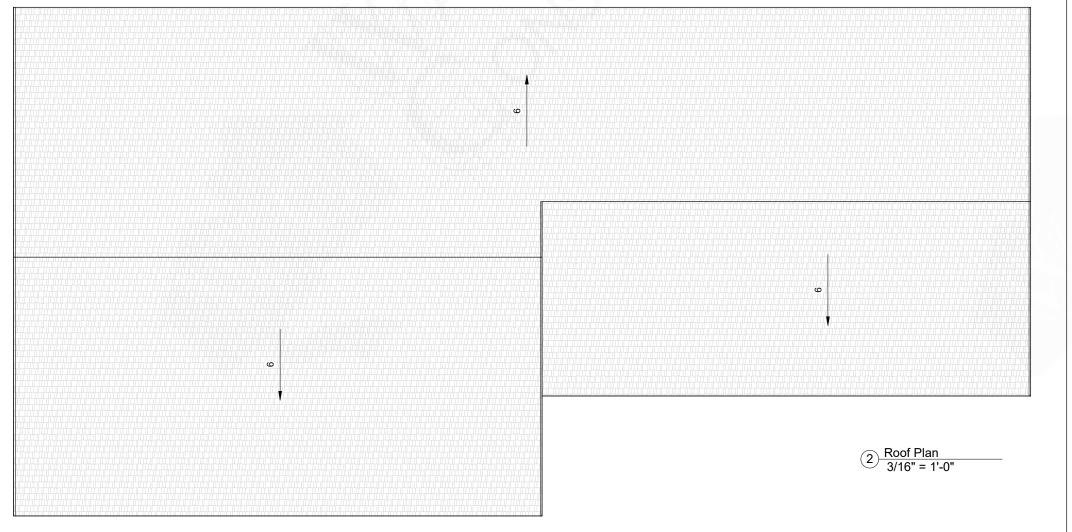

• DOOR & WINDOW OPENING SIZES • SUNBJECT TO CHOSEN MANUFACTURER WINDOWS SIZES MAY VARY FROM PLAN

• REFER TO MFG. FOR RSO SIZES FOUNDATION PLAN NOTES:

3. ALL FOOTINGS SHALL BEAR DIRECTLY ON UNDISTIRBED SOIL. (ASSUMED SOIL BEARING CAPACITY -2500 P.S.F.)

4. APPROVED GRANULAR FILL SHALL BE COMPACTED IN 6" LAYERS TO 95% STANDARD PROCTOR MAXIMUM DRY DENSITY

5. ALL EXTERIOR FOOTINGS SHALL BE A MINIMUM 4'-0" BELOW FINISGED GRADE

6. CONCRETE FOR FLOOR SLABS SHALL HAVE A MINIMUM 28 DAY COMPRESSIVE STRENGTH OF 25 MPa. ALL OTHERS CONCRETE SHALL HAVE A MINIMUM 28 DAY COMPRESSIVE STRENGTH OF 25 MPa UNLESS OTHERWISE SPECIFIED. (6% AIR/4"SLUMP)

7. REINFORCING STEEL TO HAVE MINIMUM 1 1/2" COVER, MAXIMIUM 2" COVER AT BOTTOM OF SLAB

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MAIN FLOOR 1227 SQ. FT. 2ND FLOOR COMBINED FLOOR 1227 SQ. FT. GARAGE 874 SQ. FT. 2101 SQ. FT.

Mike Wall BCIN: 104799

DESCRIPTION DATE: REV.# 05/28/19 1. PERMIT READY DRAWINGS

PROPERTY OF WALL TO WALL




PROPERTY OF WALL TO WALL

WALL TO WALL CONSTRUCTION 6716 SAWMILL RD. AYLMER ON

RICKETTS 49324 DEXTER LINE MALAHIDE TWP.

PROPOSED HOUSE PLANS FLOOR/ROOF

DRAWN BY: K.W. SCALE: As indicated REVIEWED BY: M.W. B.C.I.N. 110469 DATE: MAY **A**1 SHFFT NO:

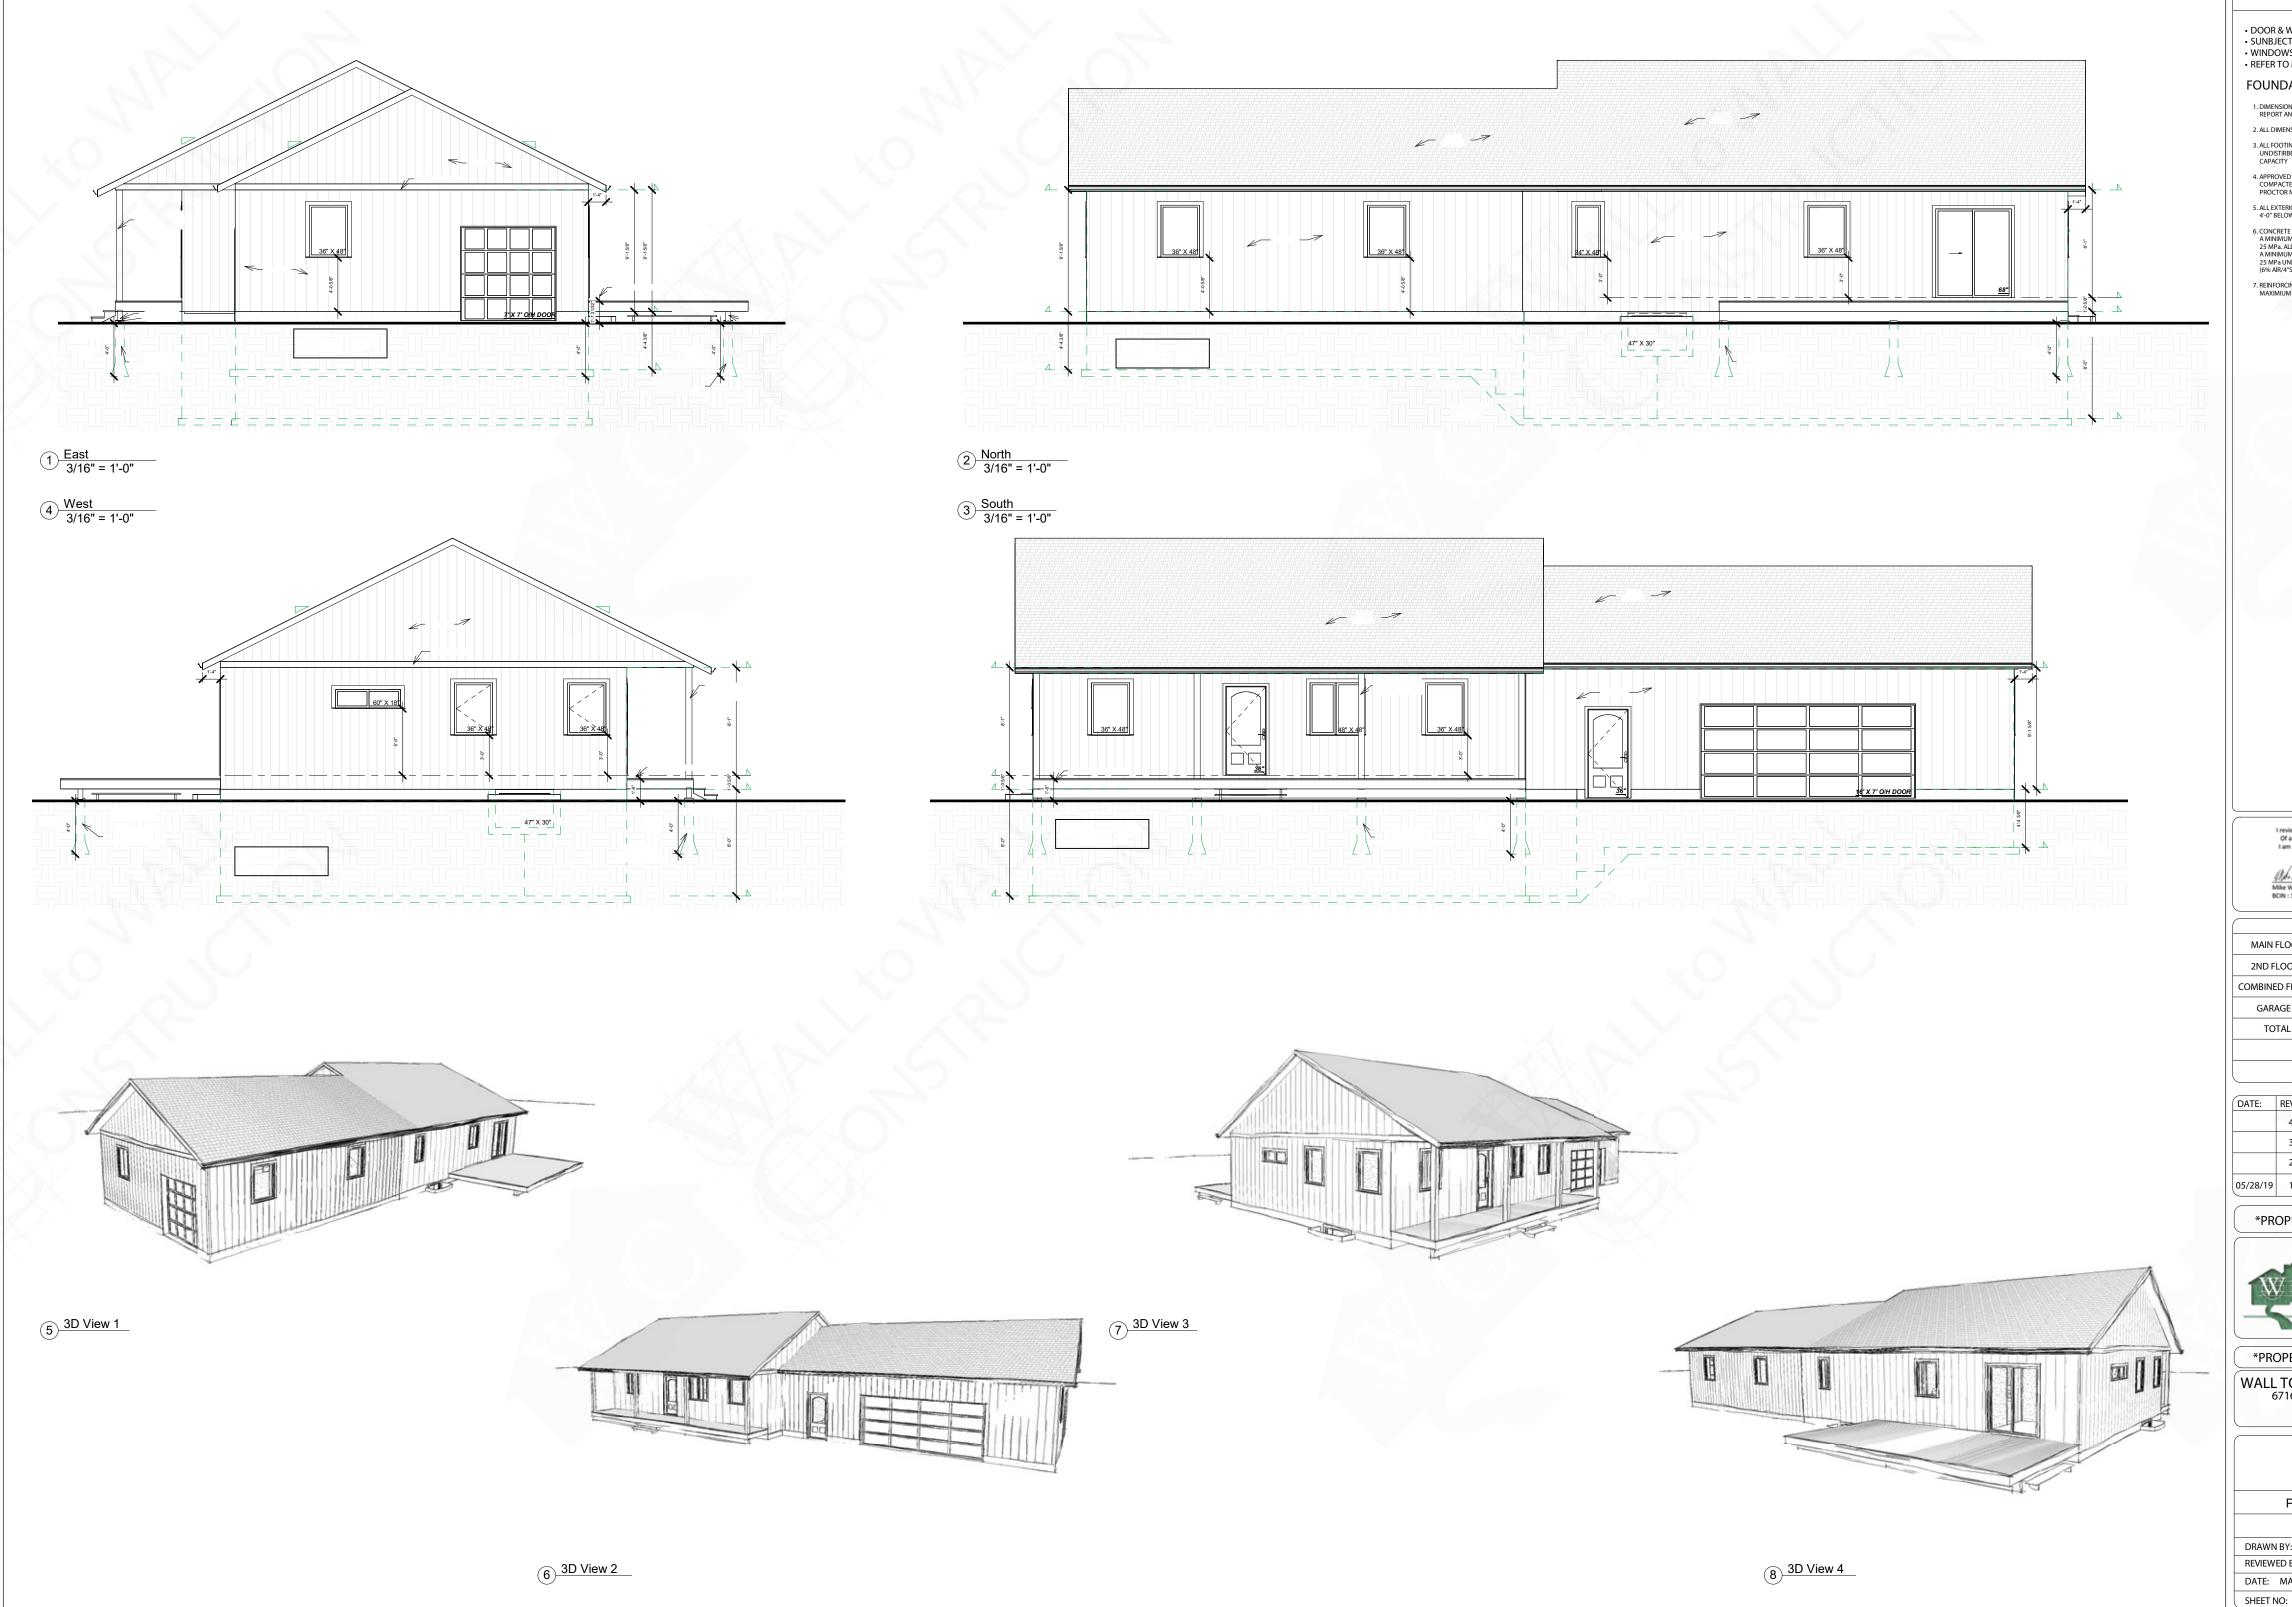

• DOOR & WINDOW OPENING SIZES SUNBJECT TO CHOSEN MANUFACTURER
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FOUNDATION PLAN NOTES:

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2. ALL DIMENSIONS TO EXTERIOR FOUNDATION WALLS

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1/16. W.U. Mike Wall BCIN: 104799

	SQUARE FOOTAGE
MAIN FLOOR	1227 SQ. FT.
2ND FLOOR	N/A
COMBINED FLOOR	1227 SQ. FT.
GARAGE	874 SQ. FT.
TOTAL	2101 SQ. FT.
	XX 6

DATE: REV	DESCRIPTION
4.	
3.	
2.	
05/28/19 1.	PERMIT READY DRAWINGS

PROPERTY OF WALL TO WALL



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WALL TO WALL CONSTRUCTION 6716 SAWMILL RD. AYLMER ON

RICKETTS 49324 DEXTER LINE MALAHIDE TWP.

PROPOSED HOUSE PLANS ELEVATIONS

DRAWN BY: K.W. SCALE: 3/16" = 1'-0" REVIEWED BY: M.W. B.C.I.N. 110469 A2